
BUILDING MAKING

PROCESS

YASH SHAH


STAGES

XX Site Demarcation XX Site Demolition and Clearing XX Site Clearing XX Site Management Site Management Plan XX Setting Out Lineout Plan XX Excavation Pit Preparation & Shoring XX Foundation Formwork Foundation Plan XX Plinth and Steps Preparation XX Load Bearing Walls, Ground Floor Ground Floor Plan XX Ground Floor Beams and Slab XX Load Bearing Walls, First Floor First Floor Plan XX Partition Walls, Window & Door Frame Installation XX Roof Structure XX Roof Work Roof Plan XX Plastering & Finishing Door - Window Detail, External Wall Section, Toilet Detail XX Entire Built Form with Site

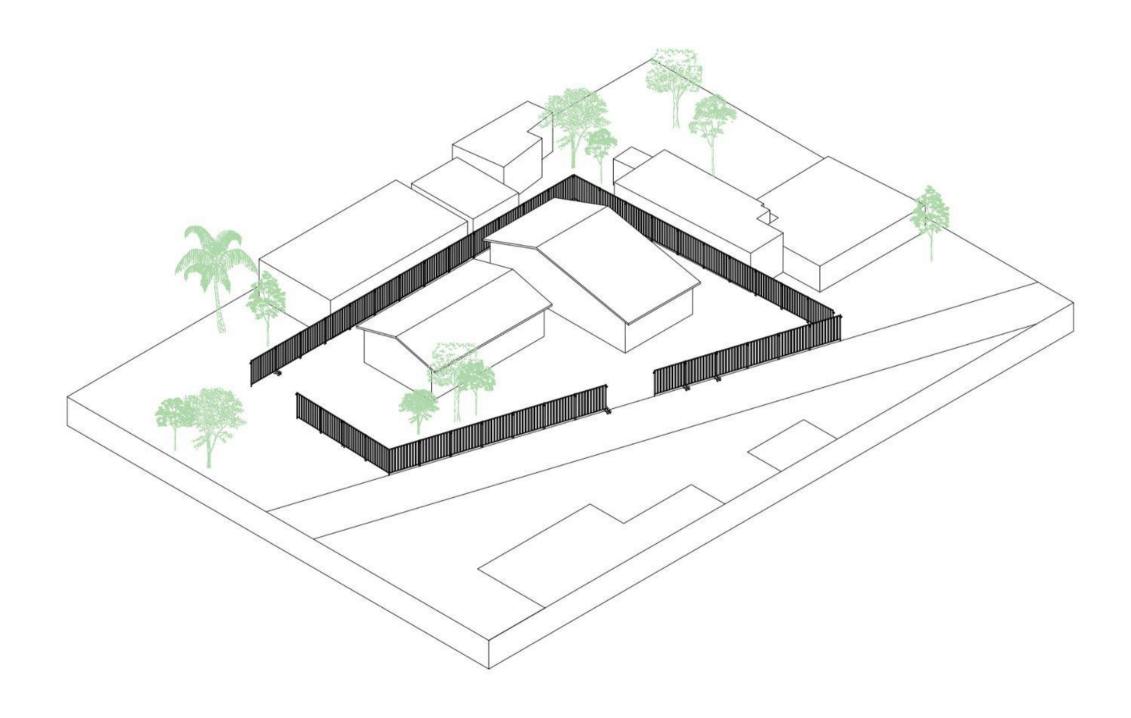


Site Demarcation

Locating and Barricading the site using corrugated sheets or fence.

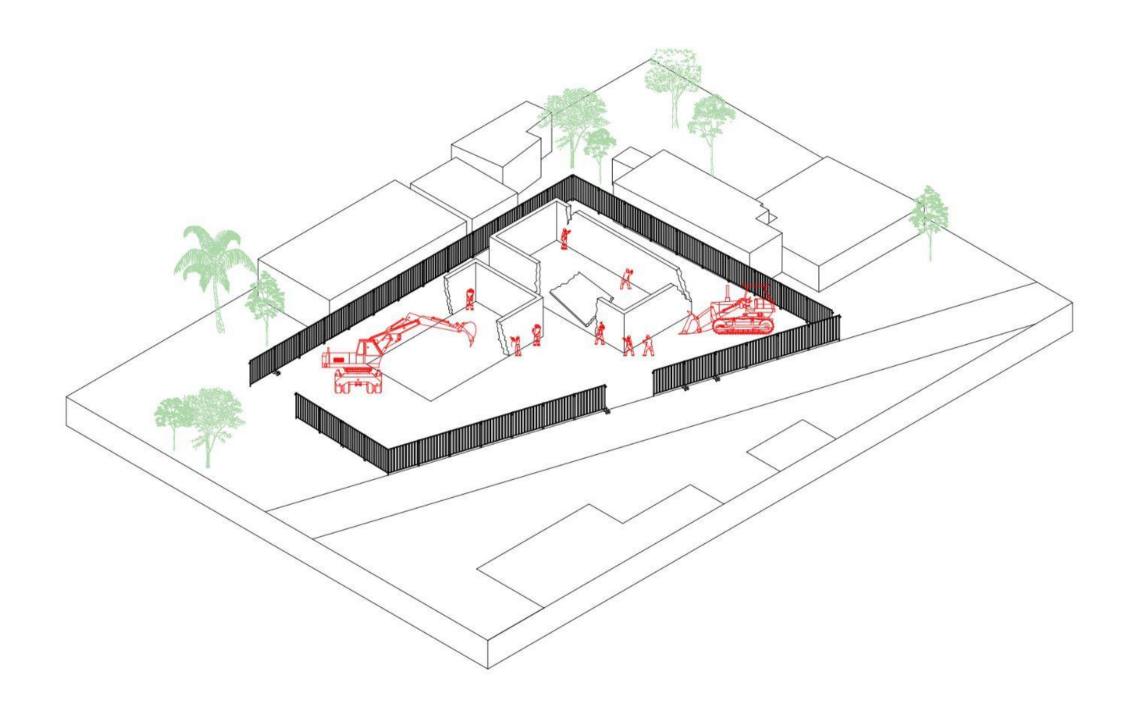

Site Demolition


Demolition of the existing structure.

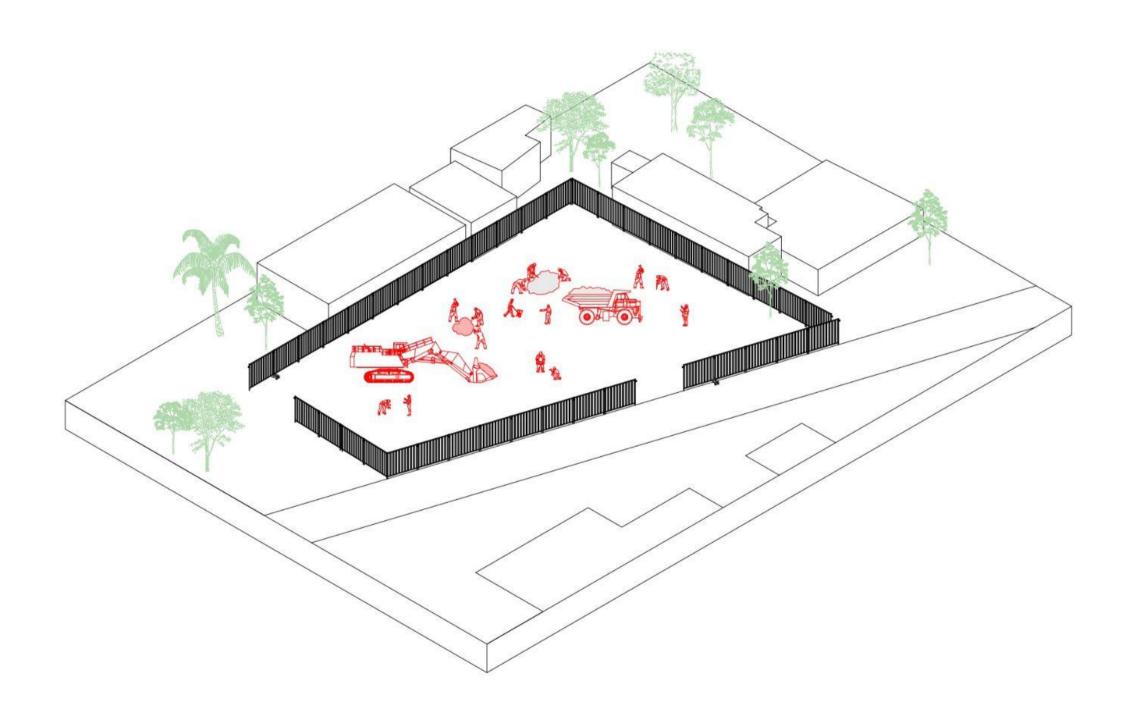


Site clearing Clearing the site and preparing for lineout.



	TASK TYPE
A	DEMOLITION AND SITE CLEARANCE
B)	DEMARCATION OF SITE
(9	PREPARATION OF GROUND (EXCAVATION, SHORING)
Œ	FOOTING/ FOUNDATION MAKING
E)	PLINTH FILLING AND PLINTH STEPS
E)	BRICKWORK FIRST LEVEL
G)	SECOND LEVEL FORMWORK (SLAB AND RUNNER BEAM
Ð	BRICKWORK SECOND LEVEL
0	ROOF
Ð	INSTALLING WINDOW/DOOR FIXTURES
R)	CONDUITING AND PLUMBING
0	FLOORING, EXTERNAL AND INTERNAL WALL PLASTER
(N	EXTERNAL AND INTERNAL FIXTURES
N)	CLEANING AND HANDOVER

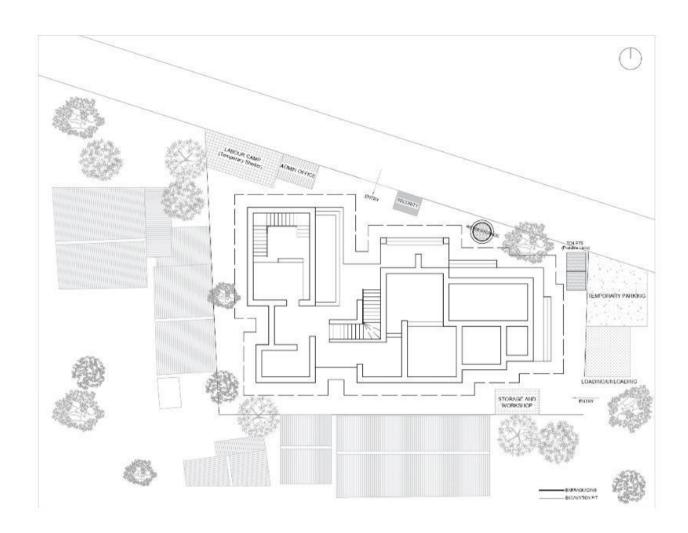

CRITICAL PATH DIAGRAM

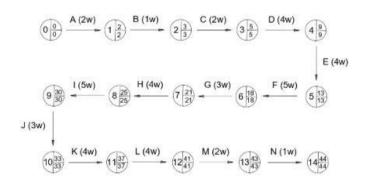

	TASK TYPE	DURATION (WEEKS)	1	2	3	4	5 6	7	8	9 .	0_1	1 12	13	14	15 1	6 17	18	19	20	21 2	22 2	3 24	25	26	27	28 2	9 30	31	32	33	34	35 3	36 3	7 38	39	40	41 4	2 4	3 44
(A)	DEMOLITION AND SITE CLEARANCE	2 WEEKS					12	3'					W 3				- 58		= 3			8		334	8		88	3					3						
(B)	DEMARCATION OF SITE	1 WEEKS															200																						
©	PREPARATION OF GROUND (EXCAVATION, SHORING)	2 WEEKS																																					
0	FOOTING/ FOUNDATION MAKING	4 WEEKS					- 10																		- 60			- 65											
(E)	PLINTH FILLING AND PLINTH STEPS	4 WEEKS					- 2																																
F	BRICKWORK FIRST LEVEL	5 WEEKS																																					
(G)	SECOND LEVEL (SLAB AND RUNNER BEAM)	3 WEEKS					-8								- 60							0						- 22											
\oplus	BRICKWORK SECOND LEVEL	4 WEEKS					- 64								8																								
1	ROOF	5 WEEKS																																					
①	INSTALLING WINDOW/DOOR FIXTURES	3 WEEKS																																					
K	CONDUITING AND PLUMBING	4 WEEKS																																					
(L)	FLOORING, EXTERNAL AND INTERNAL WALL PLASTER	4 WEEK																																					
M	EXTERNAL AND INTERNAL FIXTURES	2 WEEKS																																					
N	CLEANING AND HANDOVER	1 WEEK													- 23																								

GENERAL NOTES

All dimensions are mentioned in millimetres and levels in metres unless otherwise specified, Drawings are to be read in conjunction with other drawings. P.C.C. (1:3:6)

P.C.C. (13:6)

Decisions pertaining to material proportions, structural calculations are to be acquired from structural engineer's drawings.


All discrepancies shall be brought to the notice of the Architect before commencement of any work.

Verify field conditions and coordination with the project documents prior to proceeding with the work.

Comply with all the applicable building codes, regulations and ordinances.

All dimensions are unfinished dimensions unless otherwise specified.

ISS	UED BY	CHECKED BY

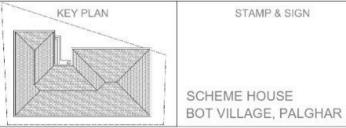

STAMP & SIGN


YASH SHAH ROLL NO | A22 - 39 THIRD YEAR B.ARCH 2024 - 2025

SCHOOL OF ENVIRONMENT AND ARCHITECTURE

NORTH SCALE 1:150


DRAWING TITLE & NUMBER


SITE MANAGEMENT WD - SEA - A - 02

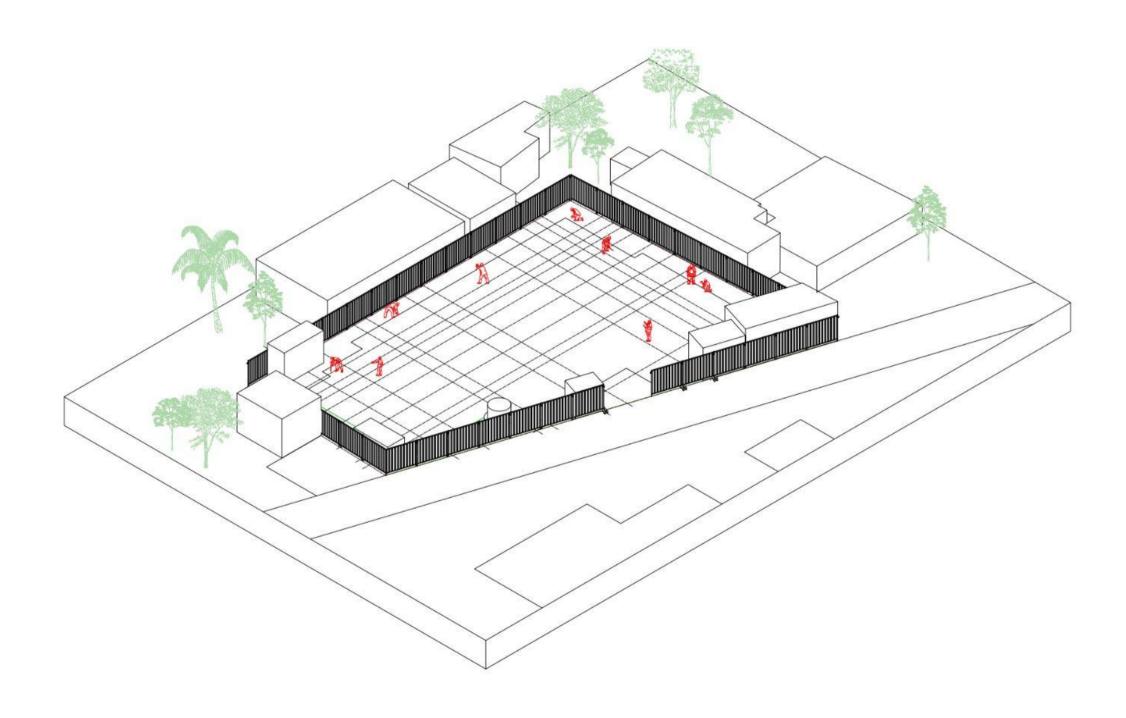

Setting Out For Excavation Pit


The Structural grid is marked on the site to start the construction.

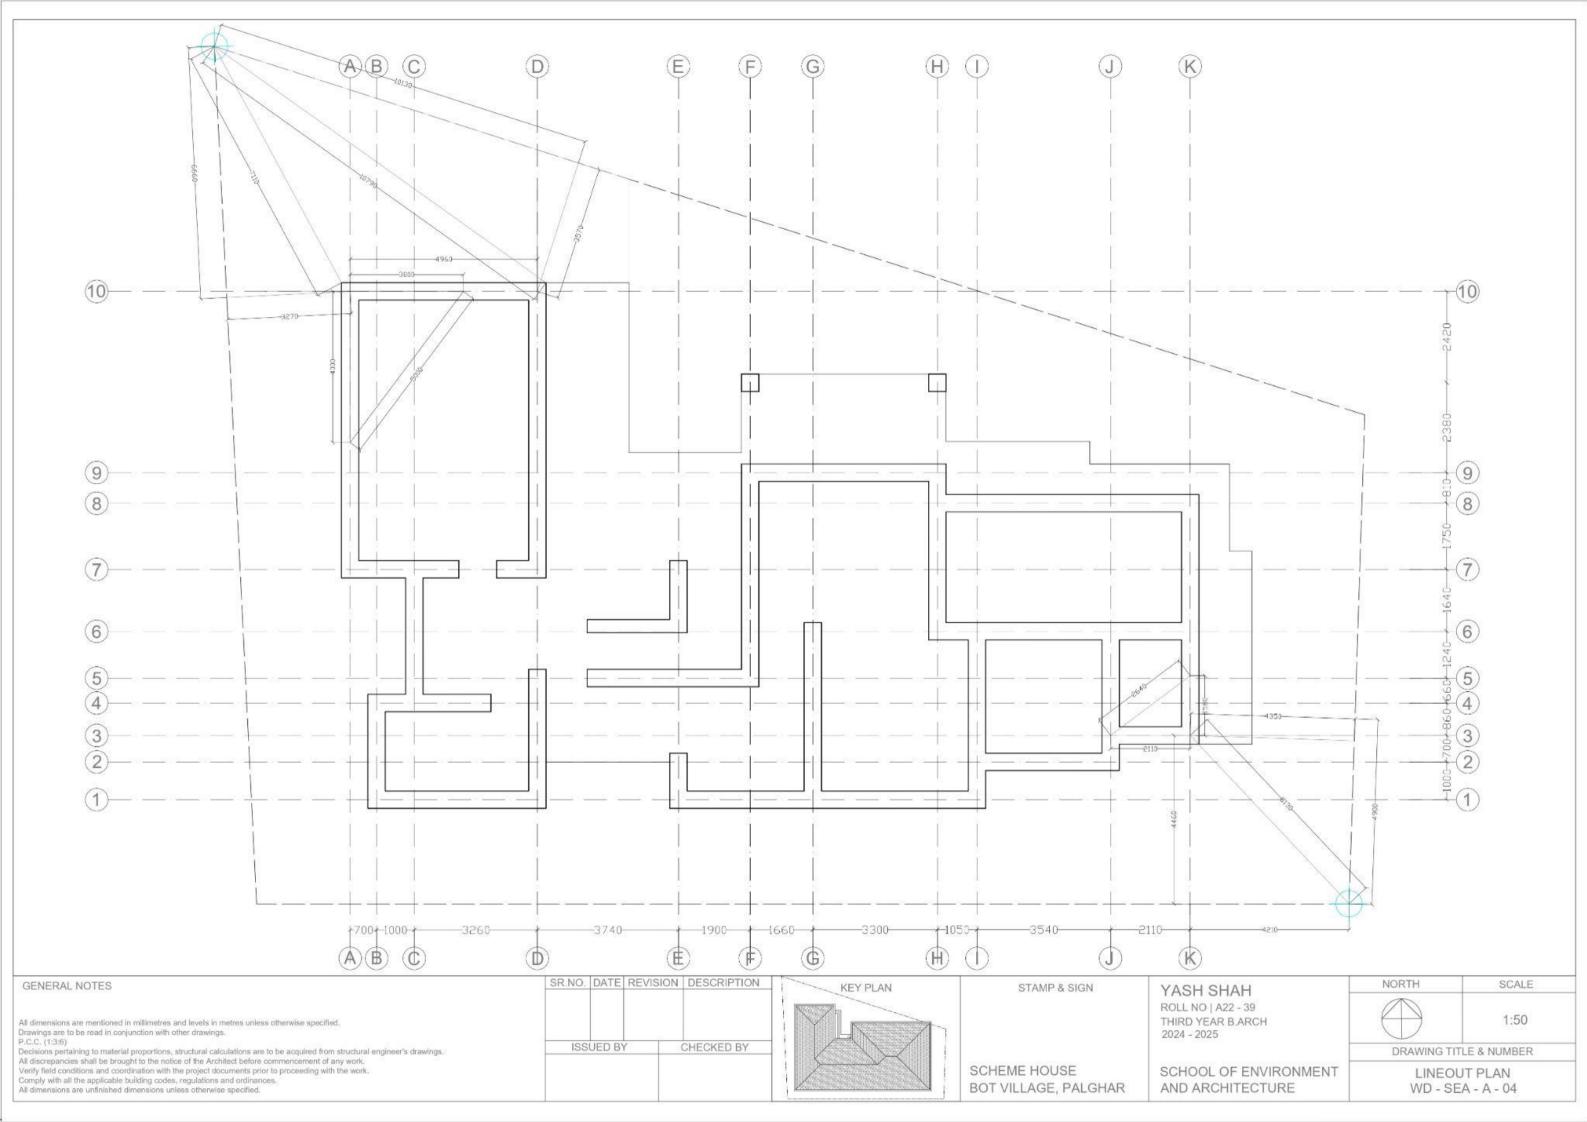

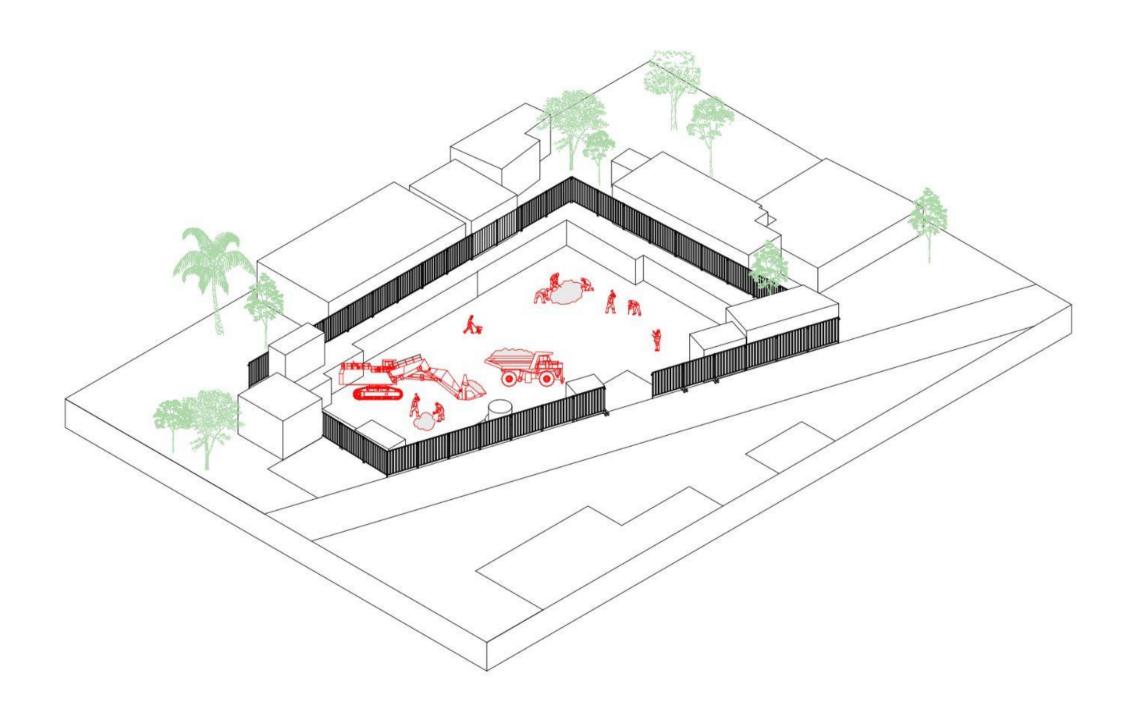


Excavation Pit Preparation & Shoring


The soil is excavated and the pit is prepared for the construction of foundation.

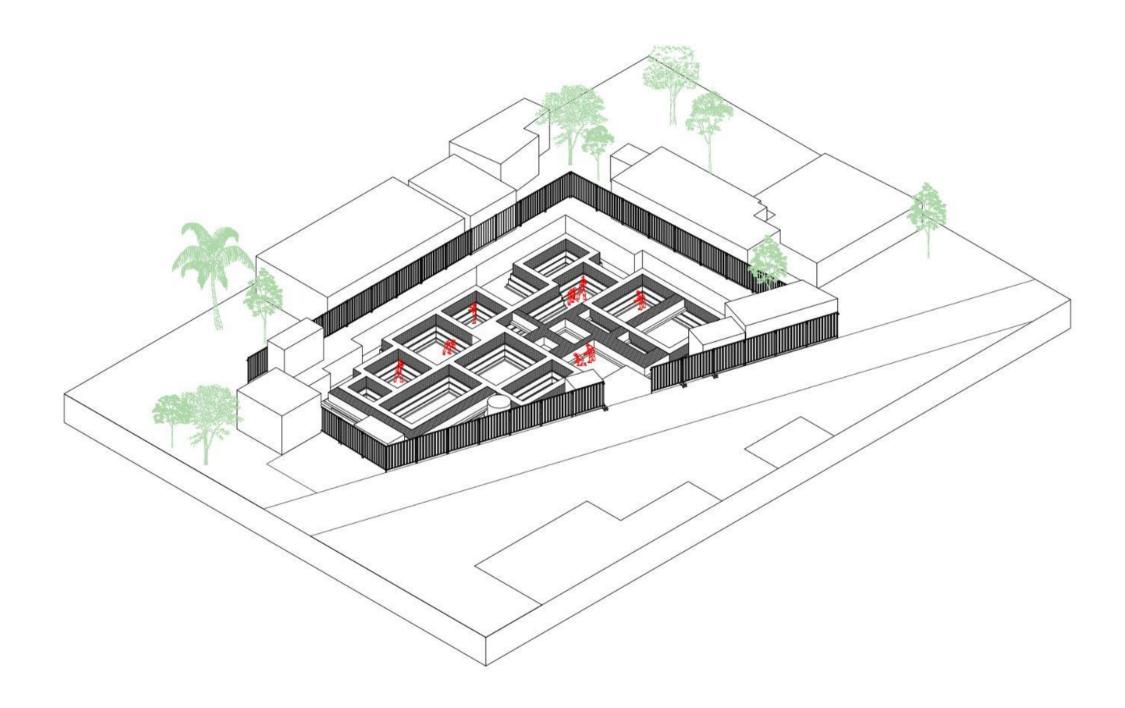



Foundation

The foundation is build till the ground floor and the soil is filled in the gaps to start the plinths construction

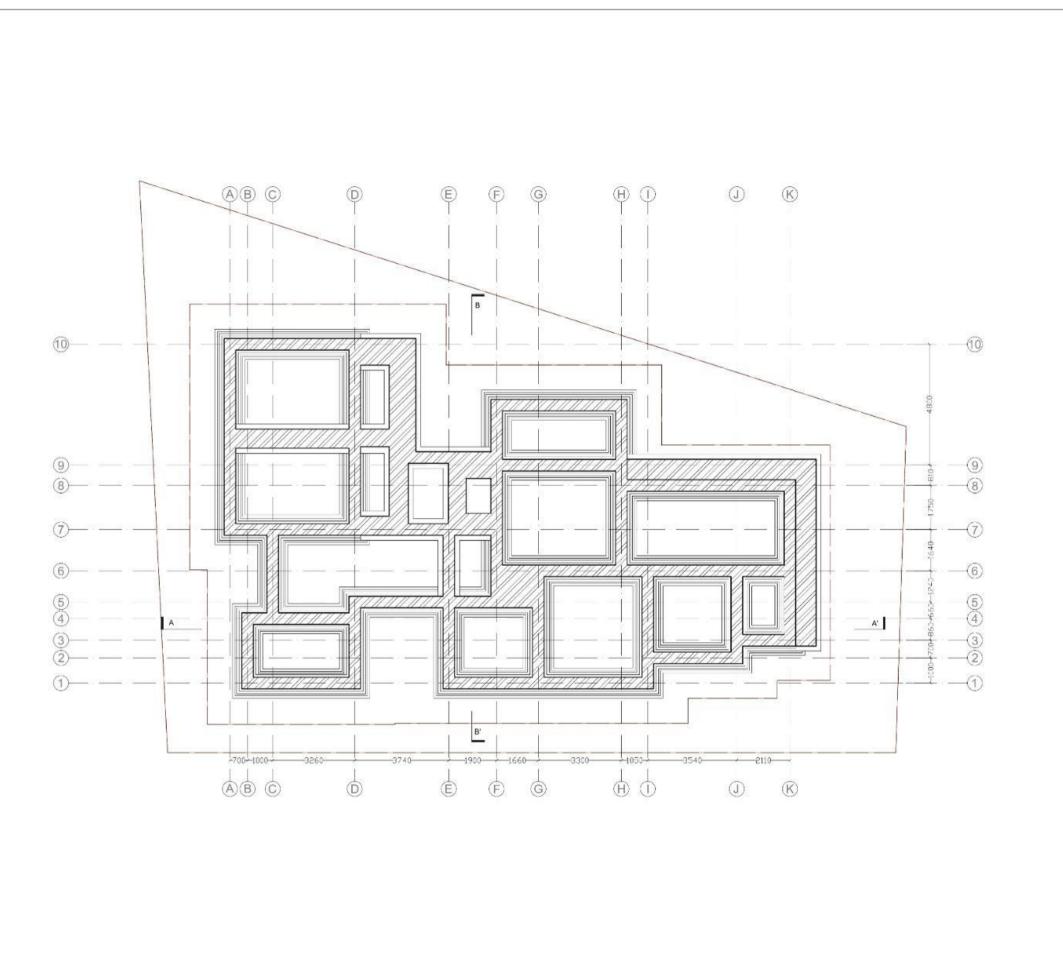

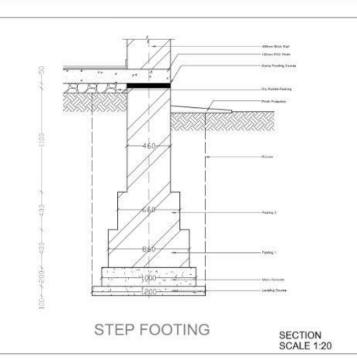

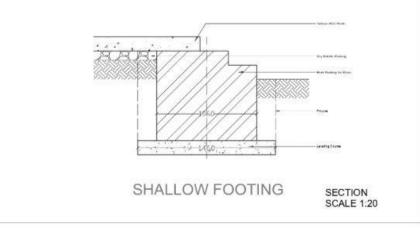


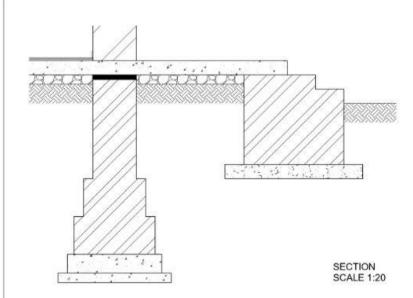

STEP FOOTING AND SHALLOW FOOTING CONNECTION


SR.NO. DATE REVISION DESCRIPTION GENERAL NOTES NORTH SCALE KEY PLAN STAMP & SIGN YASH SHAH ROLL NO | A22 - 39 1:75 All dimensions are mentioned in millimetres and levels in metres unless otherwise specified. THIRD YEAR B.ARCH Drawings are to be read in conjunction with other drawings. P.C.C. (1:3:6) 2024 - 2025 CHECKED BY ISSUED BY Decisions pertaining to material proportions, structural calculations are to be acquired from structural engineer's drawings. DRAWING TITLE & NUMBER All discrepancies shall be brought to the notice of the Architect before commencement of any work. Verify field conditions and coordination with the project documents prior to proceeding with the work. Comply with all the applicable building codes, regulations and ordinances.

All dimensions are unfinished dimensions unless otherwise specified. SCHEME HOUSE SCHOOL OF ENVIRONMENT FOUNDATION PLAN BOT VILLAGE, PALGHAR AND ARCHITECTURE WD - SEA - A - 05

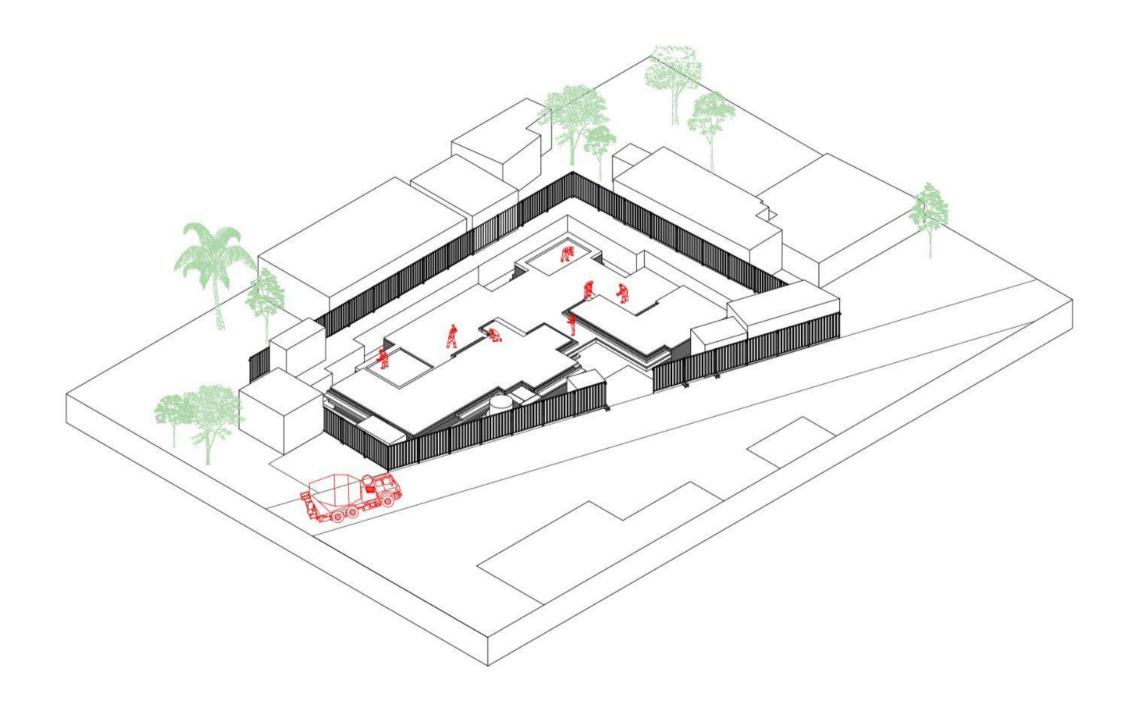


Plinth and steps


The plinth is constructed with step up and step down making the plinth at different levels.

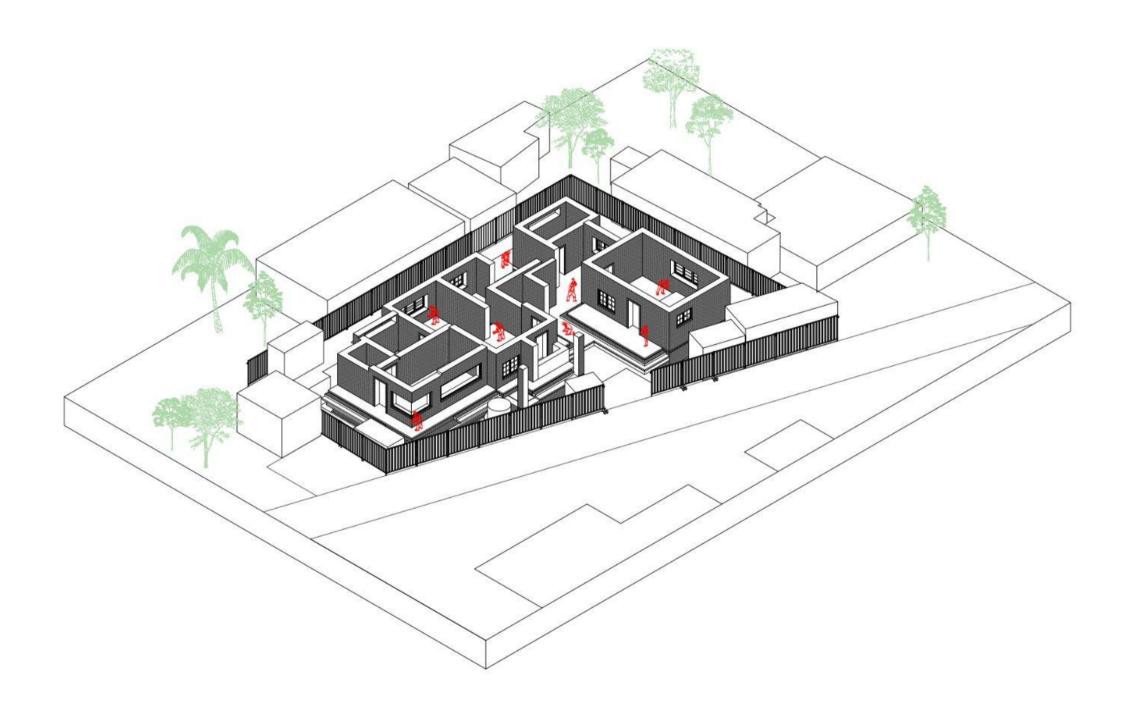

Ground floor walls, columns


The masonry walls and brick piers are constructed including the sill and lintel for openings.

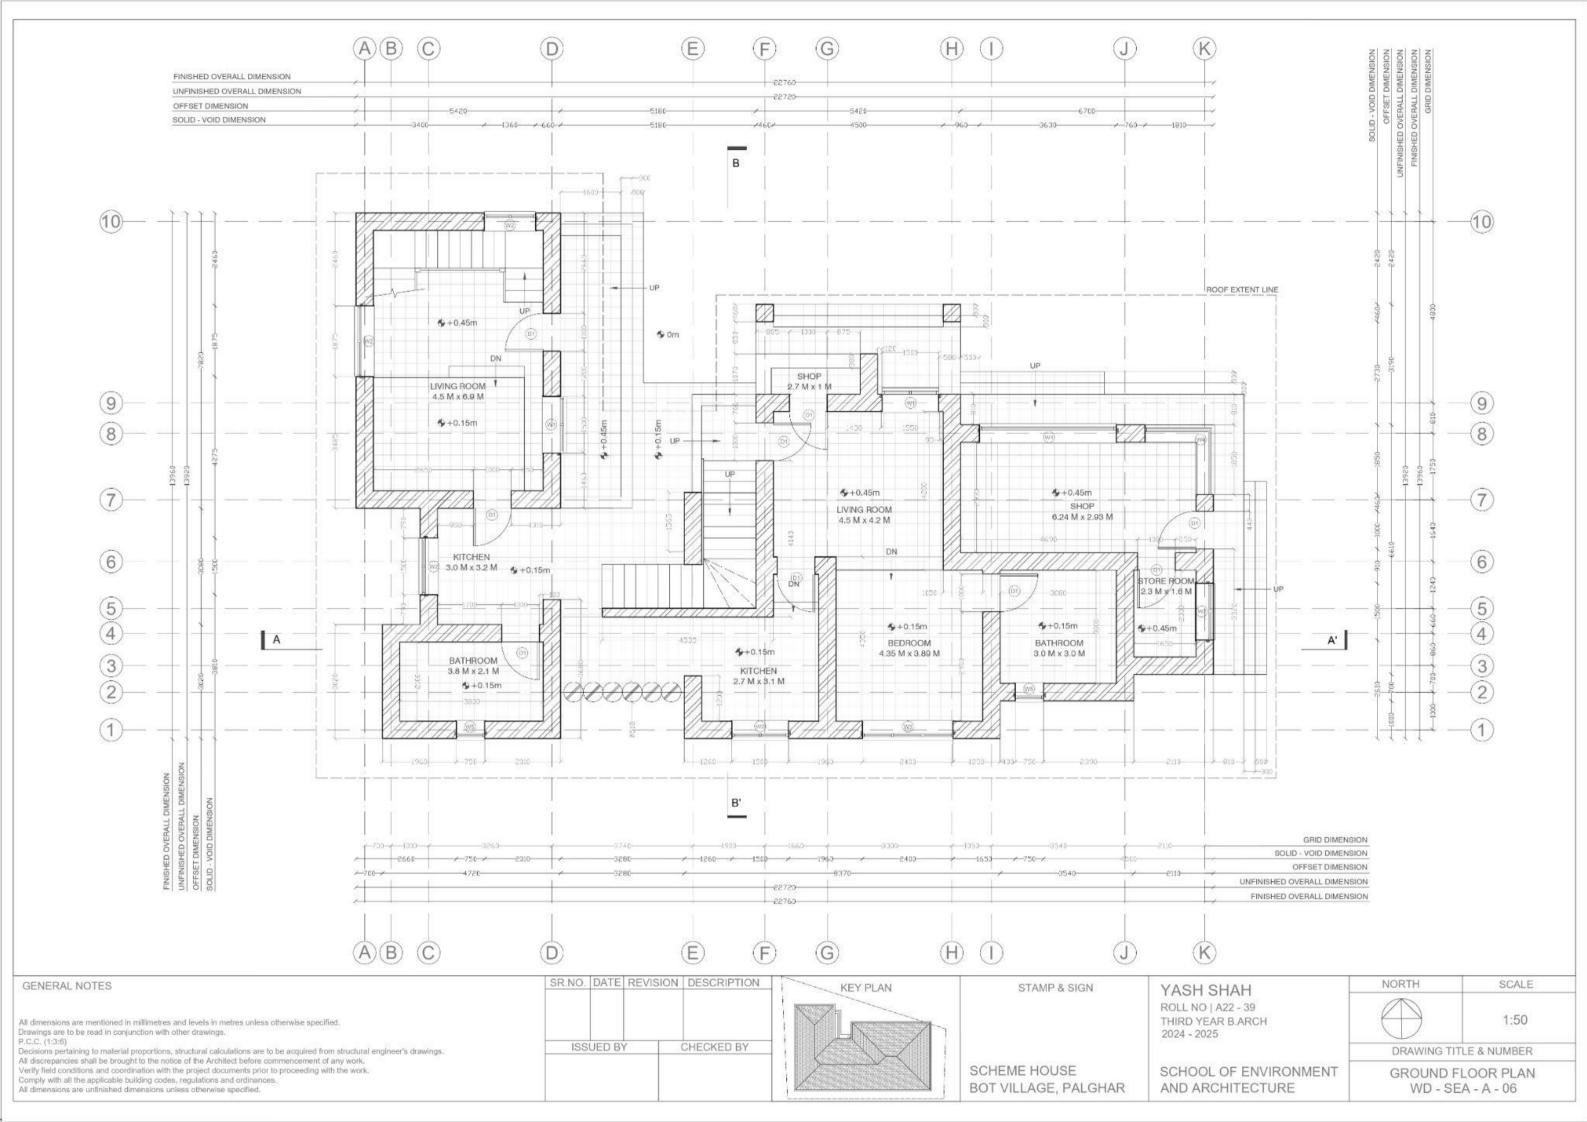

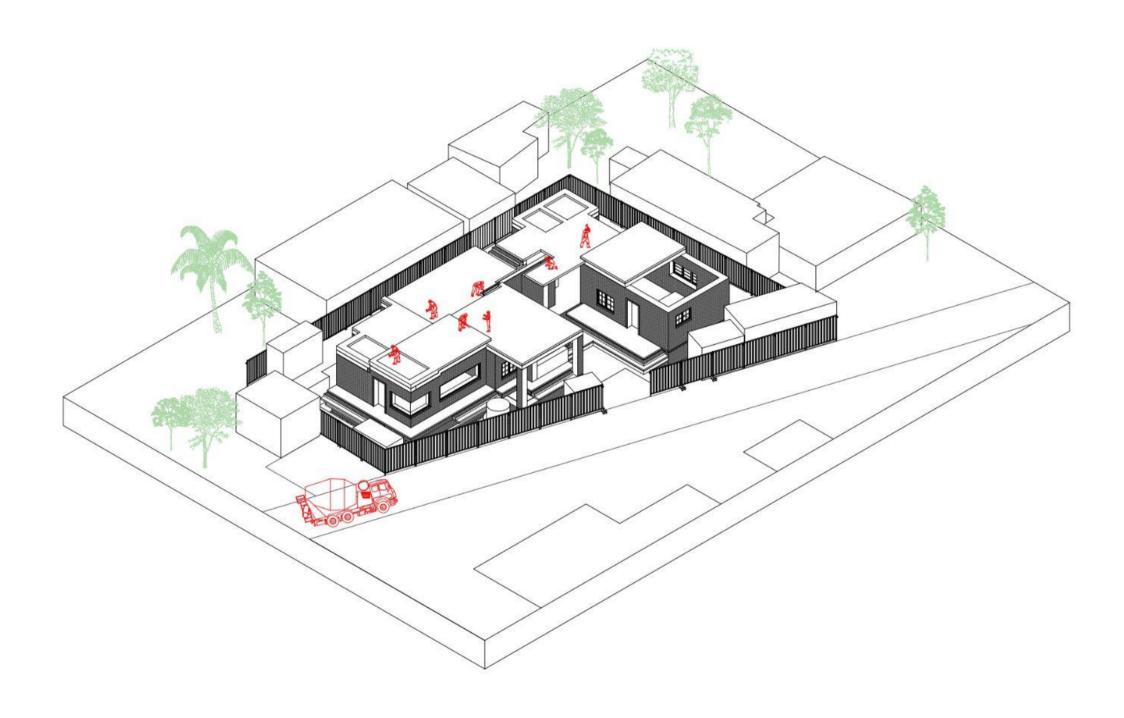


Slab and Runner Beam


The slab and runner beam is constructed on the walls for the first floor.

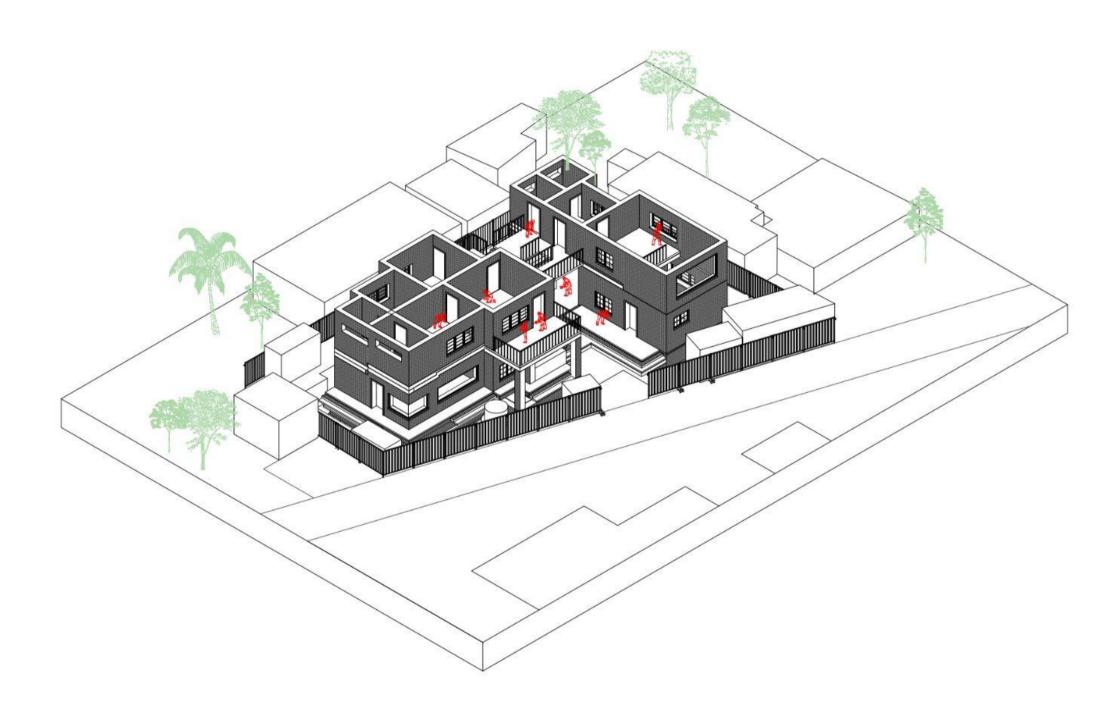

FIRST floor walls, columns and beams


Masonry walls are constructed on top of the slab.

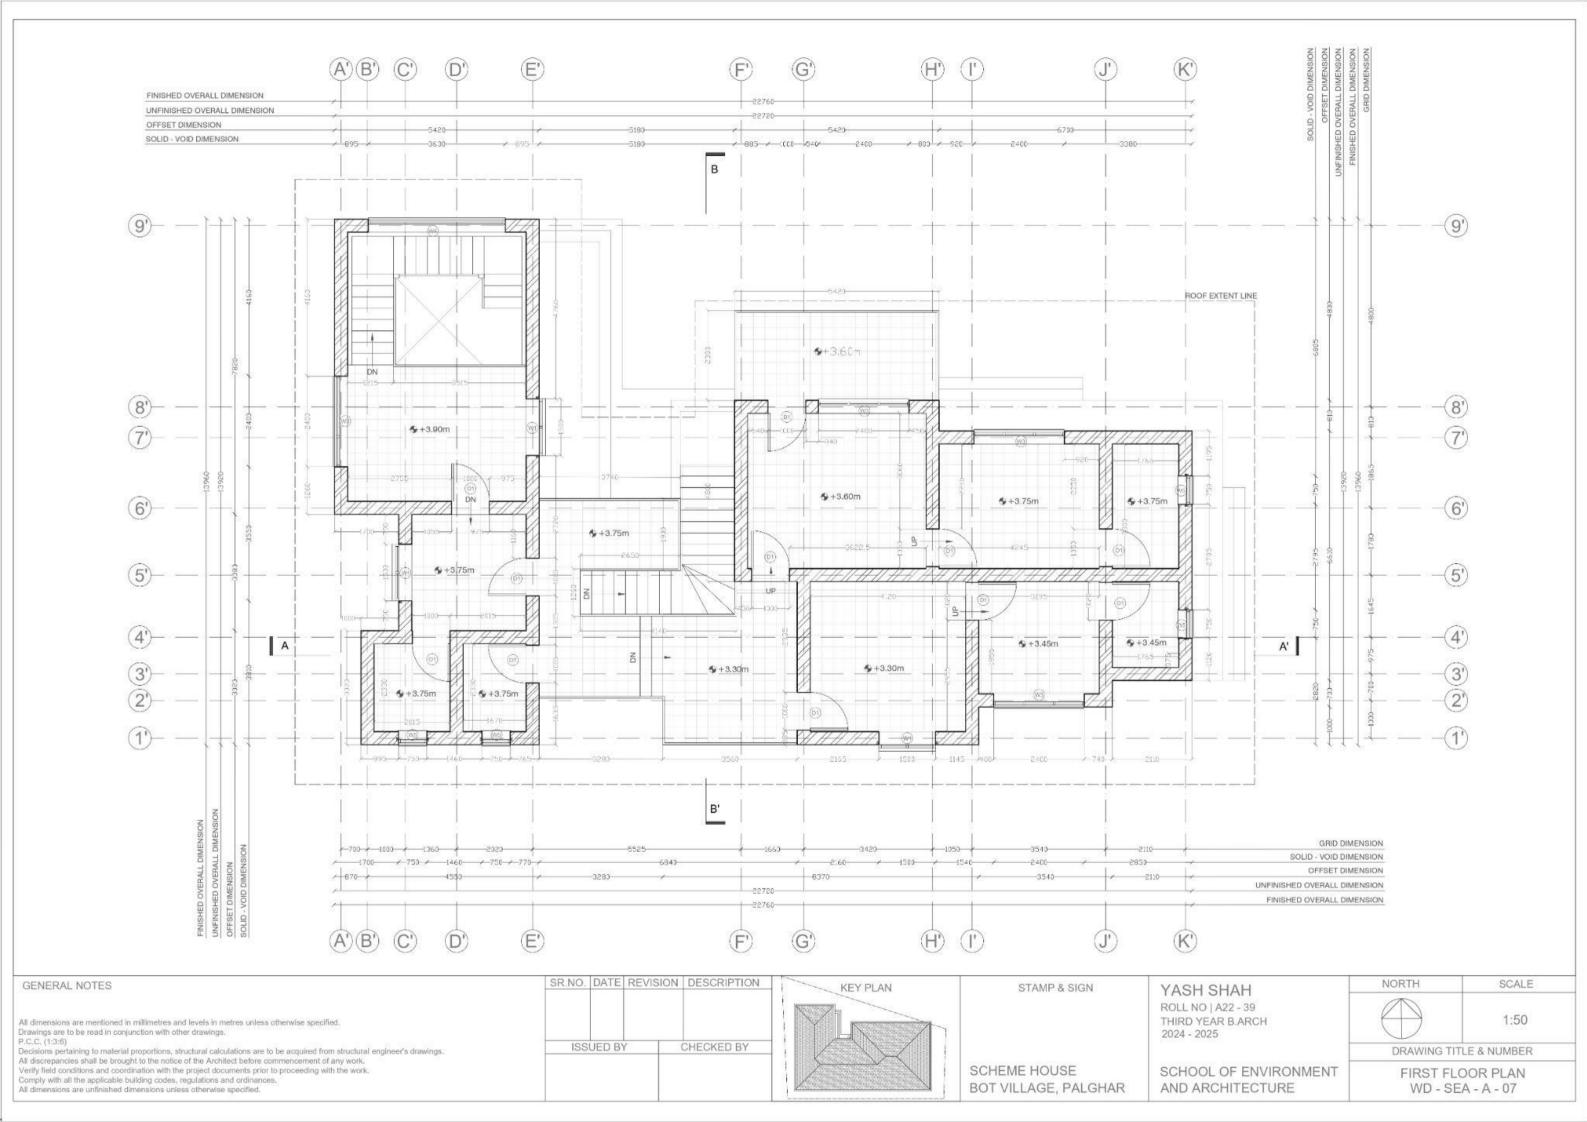


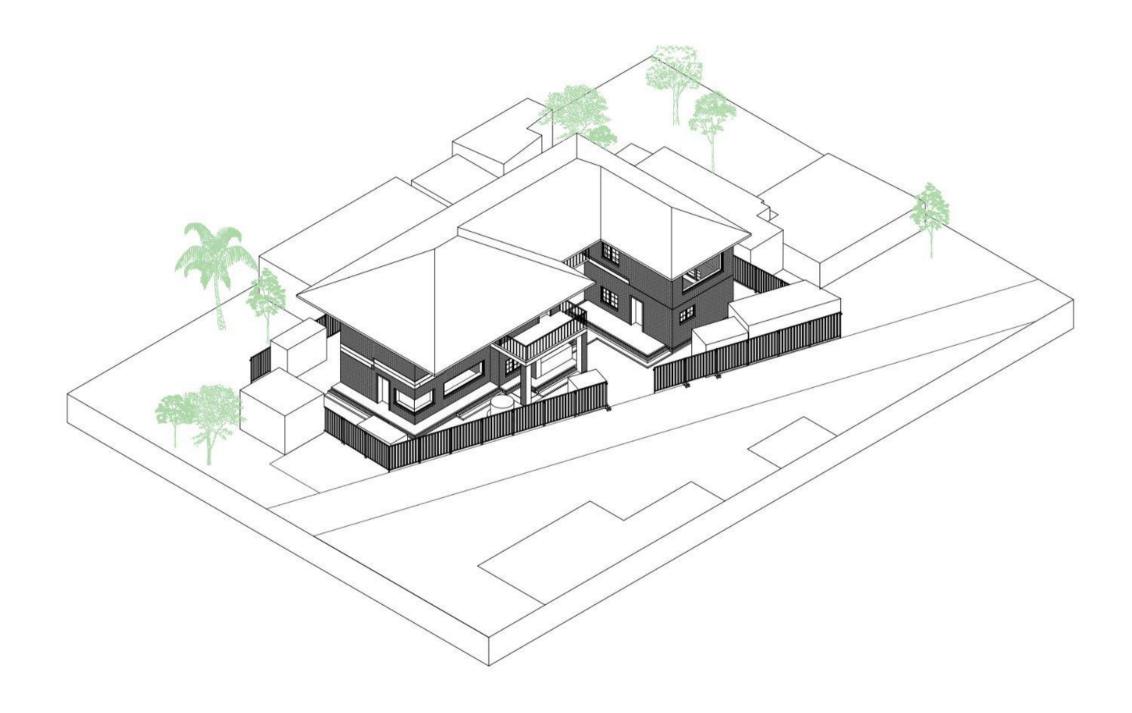

Roof work

The Mangalore tiles are placed on the members of the roof.

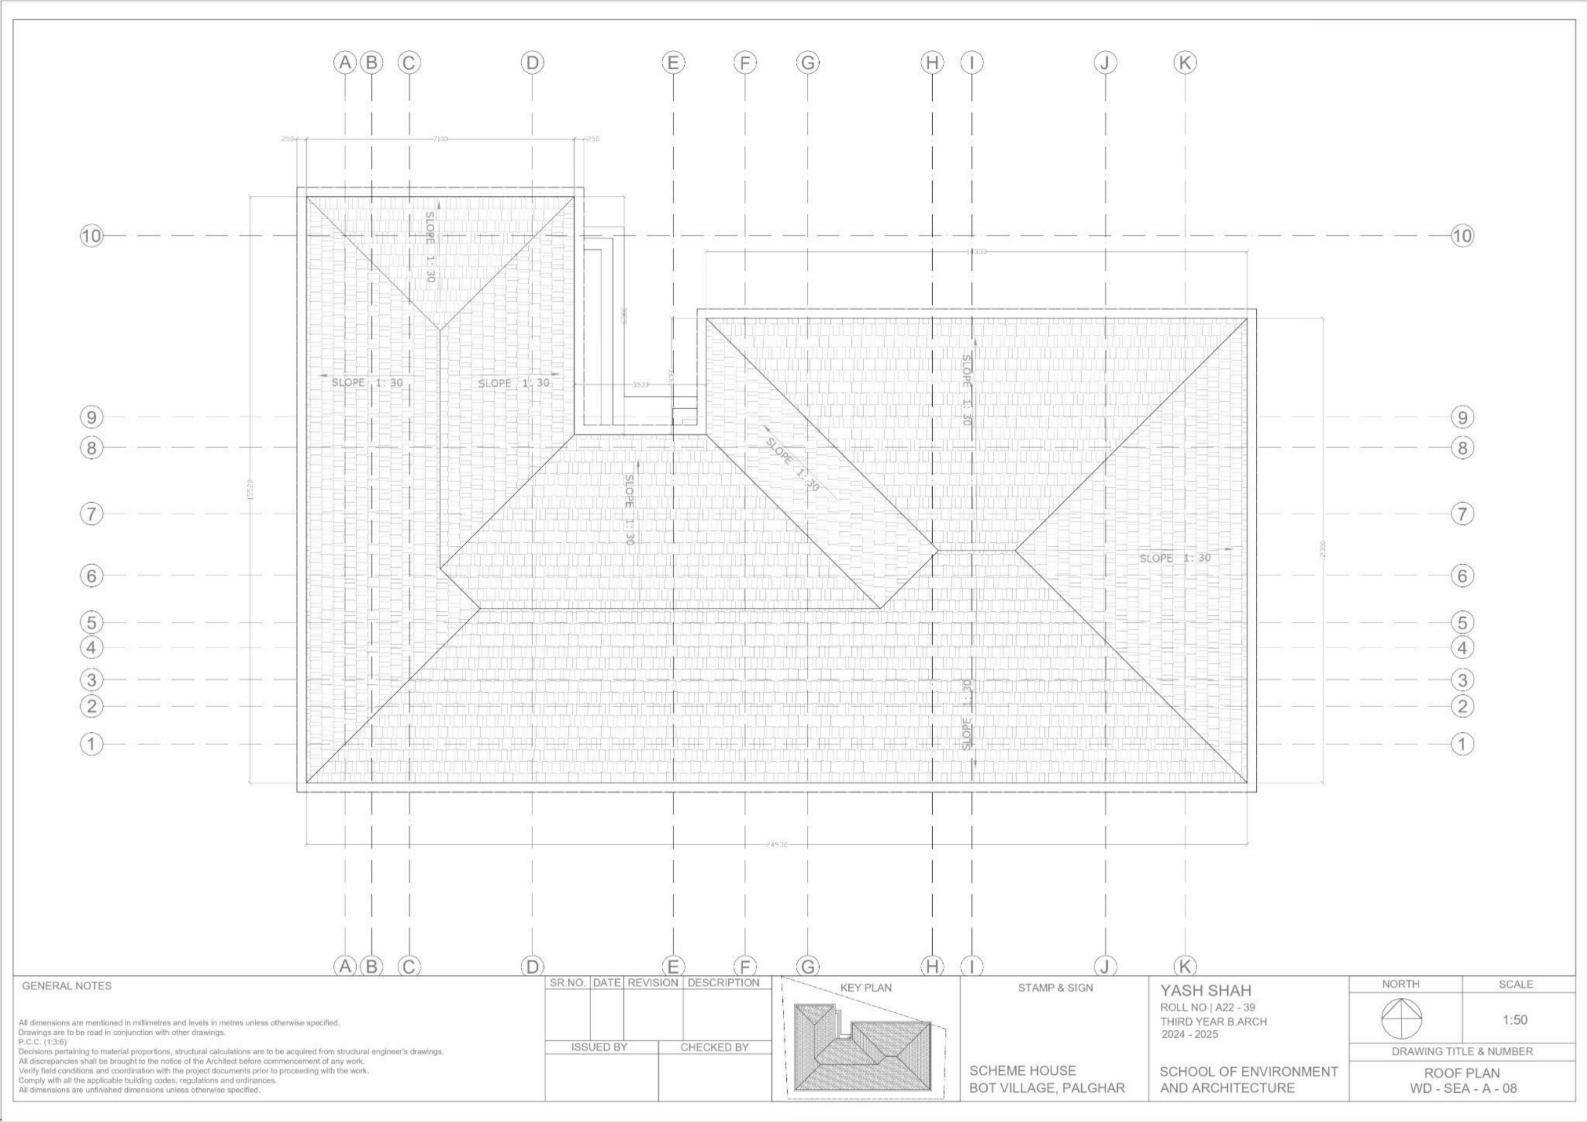

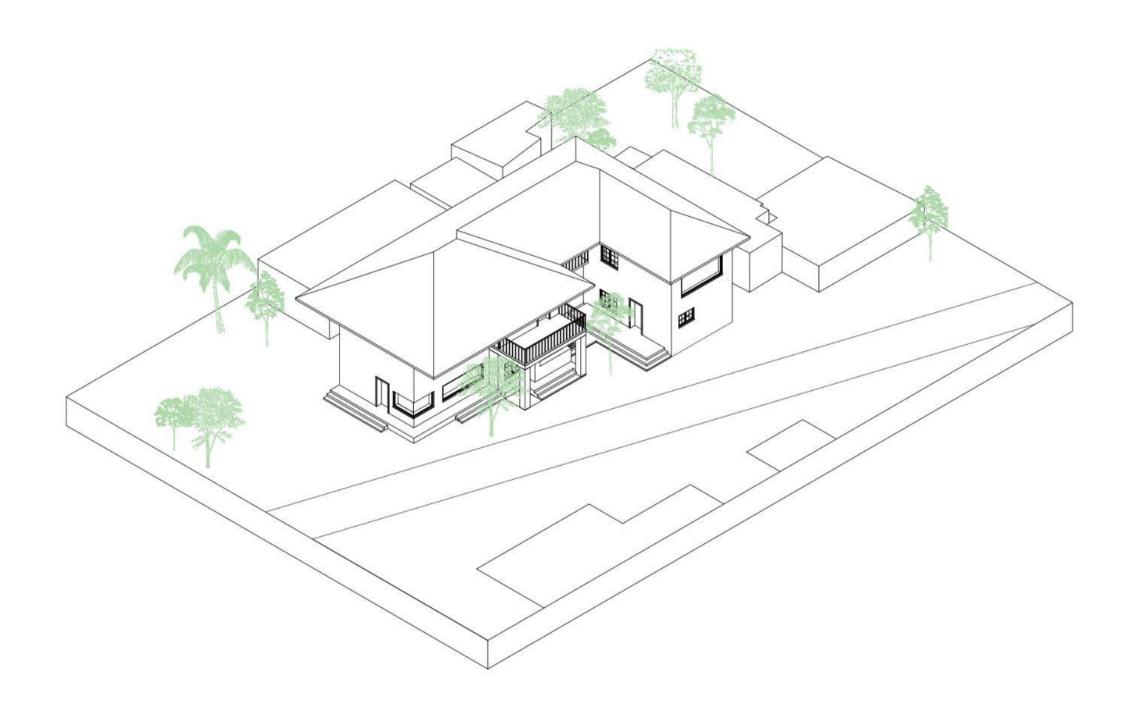

Entire Built Form with Site

After the final plastering and painting, the site is cleaned for handing over.